# **PROPOSED DUPLEX DEVELOPMENT FOR:**

# J MAGEE + W KELLY

# AT: LOT 6 #12 KANOOKA CRES, **BOGANGAR NSW VILLA ONE**

DRAWING INDEX           101         Cover Sheet           104         Site Analysis True North           105         Design Response True North           201         Site Plan           202         Shadow Diagrams           301         Ground Floor Plan Villa 1           302         First Floor Plan Villa 1           303         Elevations Villa 1           304         Elevations Villa 1           305         Section           311         Upper Roof Plan Villa 1           701         Internal Elevations           801         Electrical Plan - Ground Floor           802         Electrical Plan - First Floor           902         BASIX 01           903         BASIX 02           904         BASIX 03		
104       Site Analysis True North         105       Design Response True North         201       Site Plan         202       Shadow Diagrams         301       Ground Floor Plan Villa 1         302       First Floor Plan Villa 1         303       Elevations Villa 1         304.2       Front Fence Elevation         305       Section         311       Upper Roof Plan Villa 1         701       Internal Elevations         801       Electrical Plan - Ground Floor         802       Electrical Plan - First Floor         902       BASIX 01         903       BASIX 02		DRAWING INDEX
105       Design Response True North         201       Site Plan         202       Shadow Diagrams         301       Ground Floor Plan Villa 1         302       First Floor Plan Villa 1         303       Elevations Villa 1         304       Elevations Villa 1         305       Section         311       Upper Roof Plan Villa 1         701       Internal Elevations         801       Electrical Plan - Ground Floor         802       Electrical Plan - First Floor         902       BASIX 01         903       BASIX 02	101	Cover Sheet
201         Site Plan           202         Shadow Diagrams           301         Ground Floor Plan Villa 1           302         First Floor Plan Villa 1           303         Elevations Villa 1           304         Elevations Villa 1           305         Section           311         Upper Roof Plan Villa 1           701         Internal Elevations           801         Electrical Plan - Ground Floor           802         Electrical Plan - First Floor           902         BASIX 01           903         BASIX 02	104	Site Analysis True North
202         Shadow Diagrams           301         Ground Floor Plan Villa 1           302         First Floor Plan Villa 1           303         Elevations Villa 1           304         Elevations Villa 1           304.2         Front Fence Elevation           305         Section           311         Upper Roof Plan Villa 1           701         Internal Elevations           801         Electrical Plan - Ground Floor           802         Electrical Plan - First Floor           902         BASIX 01           903         BASIX 02	105	Design Response True North
301         Ground Floor Plan Villa 1           302         First Floor Plan Villa 1           303         Elevations Villa 1           304         Elevations Villa 1           304.2         Front Fence Elevation           305         Section           311         Upper Roof Plan Villa 1           701         Internal Elevations           801         Electrical Plan - Ground Floor           802         Electrical Plan - First Floor           902         BASIX 01           903         BASIX 02	201	Site Plan
302         First Floor Plan Villa 1           303         Elevations Villa 1           304         Elevations Villa 1           304.2         Front Fence Elevation           305         Section           311         Upper Roof Plan Villa 1           701         Internal Elevations           801         Electrical Plan - Ground Floor           802         Electrical Plan - First Floor           902         BASIX 01           903         BASIX 02	202	Shadow Diagrams
303         Elevations Villa 1           304         Elevations Villa 1           304.2         Front Fence Elevation           305         Section           311         Upper Roof Plan Villa 1           701         Internal Elevations           801         Electrical Plan - Ground Floor           802         Electrical Plan - First Floor           902         BASIX 01           903         BASIX 02	301	Ground Floor Plan Villa 1
304         Elevations Villa 1           304.2         Front Fence Elevation           305         Section           311         Upper Roof Plan Villa 1           701         Internal Elevations           801         Electrical Plan - Ground Floor           802         Electrical Plan - First Floor           902         BASIX 01           903         BASIX 02	302	First Floor Plan Villa 1
304.2     Front Fence Elevation       305     Section       311     Upper Roof Plan Villa 1       701     Internal Elevations       801     Electrical Plan - Ground Floor       802     Electrical Plan - First Floor       902     BASIX 01       903     BASIX 02	303	Elevations Villa 1
305     Section       311     Upper Roof Plan Villa 1       701     Internal Elevations       801     Electrical Plan - Ground Floor       802     Electrical Plan - First Floor       902     BASIX 01       903     BASIX 02	304	Elevations Villa 1
311     Upper Roof Plan Villa 1       701     Internal Elevations       801     Electrical Plan - Ground Floor       802     Electrical Plan - First Floor       902     BASIX 01       903     BASIX 02	304.2	Front Fence Elevation
701     Internal Elevations       801     Electrical Plan - Ground Floor       802     Electrical Plan - First Floor       902     BASIX 01       903     BASIX 02	305	Section
801         Electrical Plan - Ground Floor           802         Electrical Plan - First Floor           902         BASIX 01           903         BASIX 02	311	Upper Roof Plan Villa 1
802         Electrical Plan - First Floor           902         BASIX 01           903         BASIX 02	701	Internal Elevations
902 BASIX 01 903 BASIX 02	801	Electrical Plan - Ground Floor
903 BASIX 02	802	Electrical Plan - First Floor
	902	BASIX 01
904 BASIX 03	903	BASIX 02
	904	BASIX 03

		CLIENT S	GNAT	URES:		
	ERAL NOTES:	TILE	D DECK	<u>(S:</u>		
1. 2.	All dimensions in millimetres. Dimensions take preference to scale and are to structure not finish.					e following order over the floor layer of parchem emerproof 7
3.	Check and verify dimensions and confirm any existing dimensions marked.					of 1300 micron, installed to
4.	Work shall comply with the National Construction Code and all relevant					corners to have 20mm mastic
	current Australian Standards. Any outdated Standards listed in these notes are to be taken to refer to the current edition.			under parchem emerproof AZING TO BE USED IN T		WING CASES
5.	Manufacturers specification means a current approved specification for			ms - within 500mm vertica		
6.	use under the conditions applicable. UNO = Unless Noted Otherwise.			ooms within 1500mm verti	ical of the fl	oors
0.	DPC = Damp Proof Course.		c. Fully g d. Showe	lazed doors er screens		
	OMP = Outer Most Point.		e. Within	300mm of a door and <12		
7.	It is at the Builders discretion to position bulkheads or service panels		t. windov	v sizes are nominal only, a	actual sizes	will vary with manufacturer, fla
SITE	under floor framing to accommodate plumbing services	<u>STA</u>	IR REQI	JIREMENTS		
3112	a. Site to be excavated and or filled to levels shown.					er 190mm. Space between op
	b. Footings shall be placed as per builders spec or engineers details.					. Balustrades : min. 1000mm a accordanced with NCC 3.9.1. I
	c. Footings to found in non-expansive natural material having a minimum allowable bearing capacity of 100kPa.		stainless		table 3.9.2.	1 (Wire balustrade construction
	d. Ground surface to be sloped 1:20 (min) away from building for 900mm	REI	FORCE	D CONCRETE		
	(min) and to a point where ponding will not occur near the building. e. Dish drains and ag-pipes to be provided as indicated to facilitate			ER ENGINEERS DETAIL	S	
	drainage of water away from building into drainage system.	BLO	CKWOF		•	
<u>P00</u>	L FENCING	BRIG	CKWOR	ER ENGINEERS DETAIL: K	3	
	All pool fencing shall be a min. 1200mm high and inaccordance with AS 192	6.1		- kwork to conform to AS 37	00 2011 M	asonry in buildings
REL	AINING WALLS	ombonkmont	b. Wall	s to have a continuous car	vity kept cle	ear of mortar droppings.
	<ul> <li>All retaining walls are to comply with Council policy on retaining walls and on residential building sites.</li> </ul>			of external wall. (Approx. 2		
	<li>b. Position of retaining walls may vary and must be verified by builder prior to commencement.</li>	)		vide wall ties at 600mm sp		
	c.Any variation at construction stage to comply with Council policy.			ntal and within 300mm of a vanised.	articulation j	oints. Brick ties to
	These plans are to be read in conjuction with any structural and civil engineering computions and drawings	STE	ELWOR			
	All buildings shall be protected against termite attack in accordance with AS			ER ENGINEERS DETAIL	S	
	3660.1 and a durable notice shall be left in the meter box indicating type of b and required periodical inspections			ER AS 1684. 2010 Nation	nal timber f	raming code
	Smoke detectors to be hard wired with emergency back-up and comply with	AS3786 WE1				
	Wind speed as nominated on bracing plan or soil test			r surfaces to bath & laund Id floor flashed to prevent I		impervious, with junctions betv enetration into walls.
	Provide lift-off hinges to WC or open out door or min. 1200mm clearance from door to pan.					nd AS 3740. Splashbacks shal
	All construction materials supplied must take into account proximity to coasta	al	imperv	ious for 150mm above sin	ks, troughs	and hand basins within 75mm
	or industrial environments, in accordance with manuf. specifications			amic tiles or other approve ove floor.	d imperviou	is material to walls above show
	These plans are protected by copy right and are the property of the author. All works shall comply with but not limited to the National Construction Code	and LEC	SEND			
	the australian standards listed below.	and	WIR	Walk in Robe	SD	Ionisation Smoke Alarm
				Laundry	LB	Load Bearing
	AS 1288 - 2006 GLASS IN BUILDINGS SELECTION AND INSTALLATION		ENS PWD	Ensuite Powder Room	CJ AHD	Construction Joint Australian Height Datum
	AS 1562 - 2006 DESIGN AND INSTALLATION OF SHEET ROOF AND WA	LL CLADDING		Broom Cupboard	FFL	Finished Floor Level
	AS 1684 - 2010 NATIONAL TIMBER FRAMING CODE		UBO WO	Under Bench Oven Wall Oven Tower	AS BCA	Australian Standards Building Code of Australia
	AS 2049 - 2002 ROOF TILES		OHC		TBC	To Be Confirmed
	AS 2050 - 2002 INSTALLATION OF ROOF TILES		DW MW	Dishwasher Microwaye	DEB LBW	Deep Edge Beam Load Bearing Wall
	AS 2870 - 2011 RESIDENTIAL SLAB AND FOOTINGS - CONSTRUCTION		B.BAR	Breakfast Bar	RL	Relative Level
	AS /NZS 2904 - 1995 DAMP-PROOF COURSES AND FLASHINGS		FW HWS	Floor Waste Hot Water System	NGL DP	Natural Ground Level Down Pipe
	AS 3600 - 2009 CONCRETE STRUCTURES		TAP	Ext. 12mm Hose Cock	SHS	Square Hollow Section
		DES	IGN LOA	<u>ADS</u> izes of timber members de	oducod fron	n AS 1684
	AS 3660 - 2000 BARRIERS FOR SUBTERRANEAN TERMITES AS 3700 - 2011 MASONRY STRUCTURES		b. All r		educed from	n Australian Domestic Construe
	AS 3740 - 2011 MASONET STRUCTURES AS 3740 - 2010 WATERPROOFING OF WET AREAS IN RESIDENTIAL BU	II DINGS	c. Size		vary upon o	ordering requirements but mus
	AS 4055 - 2006 WIND LOADING FOR HOUSES		•	AND CONSTRUCTION	natonal.	
	AS 4100 - 1998 STEEL STUCTURES		APPLICA	BLE - REFER DWG FOR		LS USED. Is to be checked for soundness
			<i>.</i> mai			

### **Cover Sheet**

USE FIGURED DIMENSIONS AT ALL TIMES. REFER ANY DISCREPENCIES TO INSPIRED BUILDING DESIGNS . FAILURE TO DO SO WILL VOID DESIGNERS RESPONSIBILITIES.

ALL DIMENSIONS TO BE VERIFIED ON SITE PRIOR TO CONSTRUCTION. ALL WORK TO COMPLY WITH LOCAL AUTHORITY REGULATIONS AND NCC.												
REAL PROPERTY DESCRIPTION		PROJECT ADDRESS:		CI	LIENT:			BUILDER:		DESIGN:	ISSUE:	A 17/02/22 PRELIMINARY PLANS ISSUED
				I I	MAGEE + W					NEW RESIDENCE		B 09/03/22 CONTRACT PLANS ISSUED
PLAN NUMBER: DP1273771		LOT 6 #12 KANOOKA CRI	FS	J		NLLLI		Eco-Essence	Homes	HEIT REGIDENCE		B 05/04/22 CONTRACT PLANS (SITEPLAN UPDATE)
			,							FACADE:		B 14/04/22 CONTRACT PLANS (SITEPLAN UPDATE)
LOCAL AUTH: TWEED SHIRE		BOGANGAR NSW						ADDRESS: 80 Wommin Bay Road,				D 23/05/22 CONTRACT PLANS RE-ISSUED (SEWER PUMP)
LOCAL AUTH: TWEED SHIRE		Deernernern						Chinderah NSW 2487				E 26/04/23 CONTRACT PLANS RE-ISSUED (RFI)
							_	PHONE : 07 5520 0720		STAGED PLAN:		
AREA: 1008 m2		IBD JOB 0260 DATE: 26/04/2023	DRAWN: BC	CHECKEDBC	SCALE:	DWG NO: 101	A3	WEB: www.eccessencehomes.com.au	NSW LIC: 227643C QBCC LIC: 1181578	CONTRACT		
			50	50			70	WEB: www.ecoessencenomes.com.au	QD00 El0. 11010/0	••••••		
THIS DESIGN IN PART OR WHOLE IS SUB	BJECT TO COPYRIGHT © ECO ESSENCE HOMES											

flashing all round

open treads above . For tion -

- m per metre

etween

- nall be
- nm of the wall.


nowers to 1800mm

ruction


ust remain within the

All material shall be new UNO. Reused items to be checked for soundness etc. prior to use.


	Elevation 3
)	levation levation
	Elevation 1

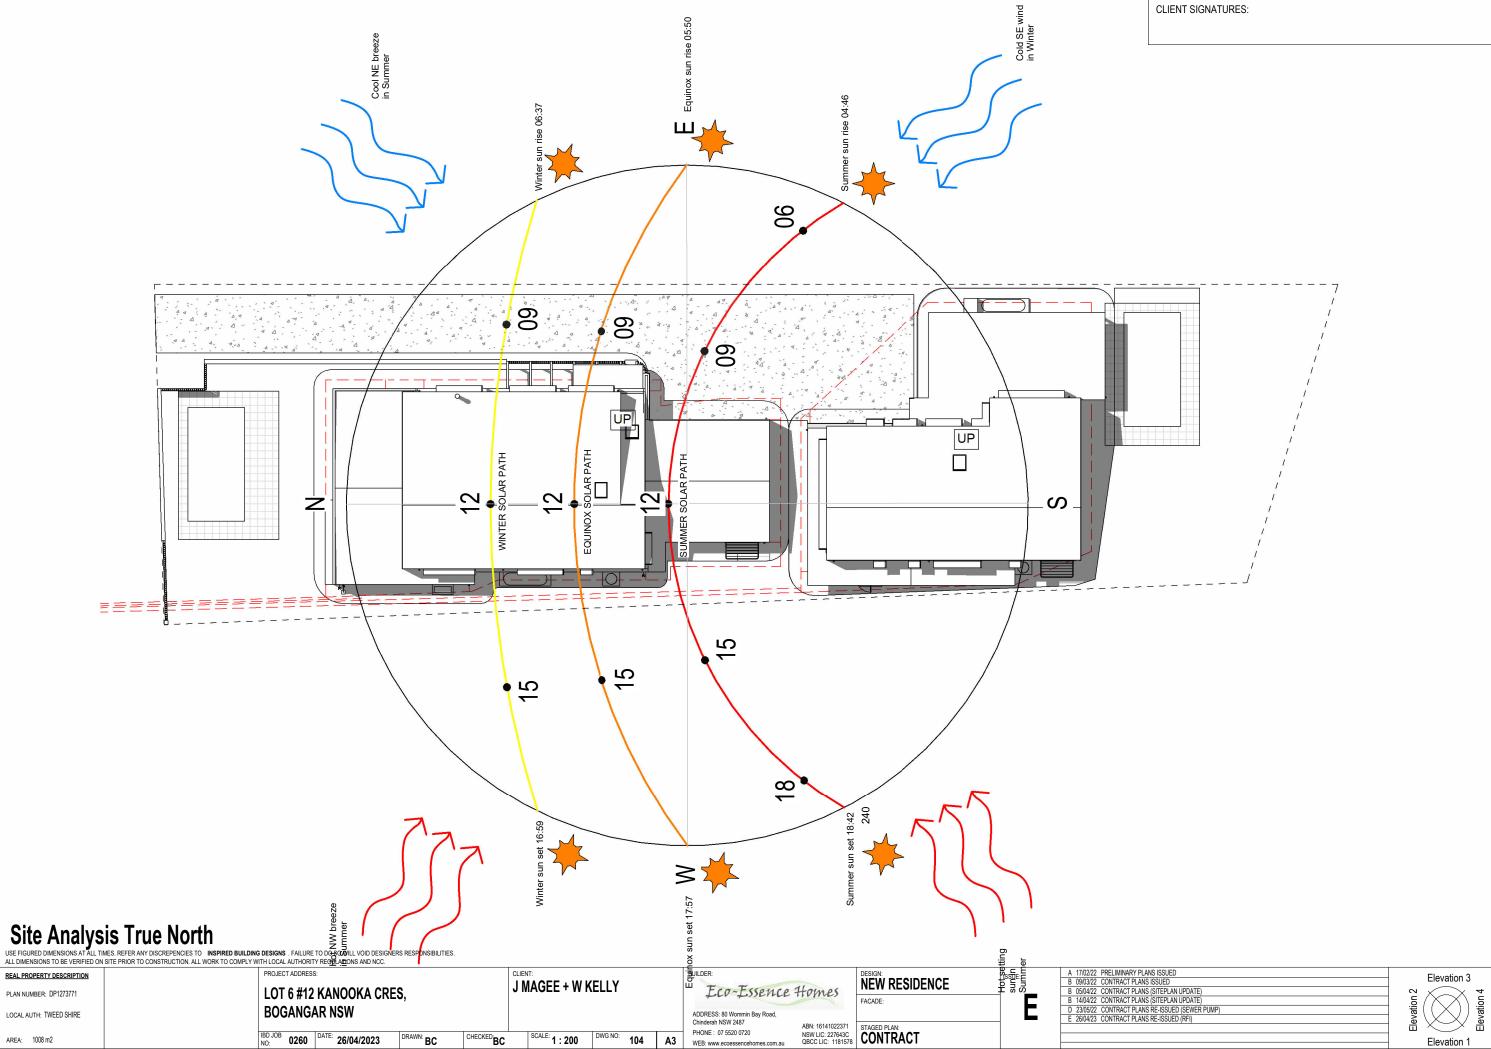


THIS DESIGN IN PART OR WHOLE IS SUBJECT TO COPYRIGHT © ECO ESSENCE HOMES

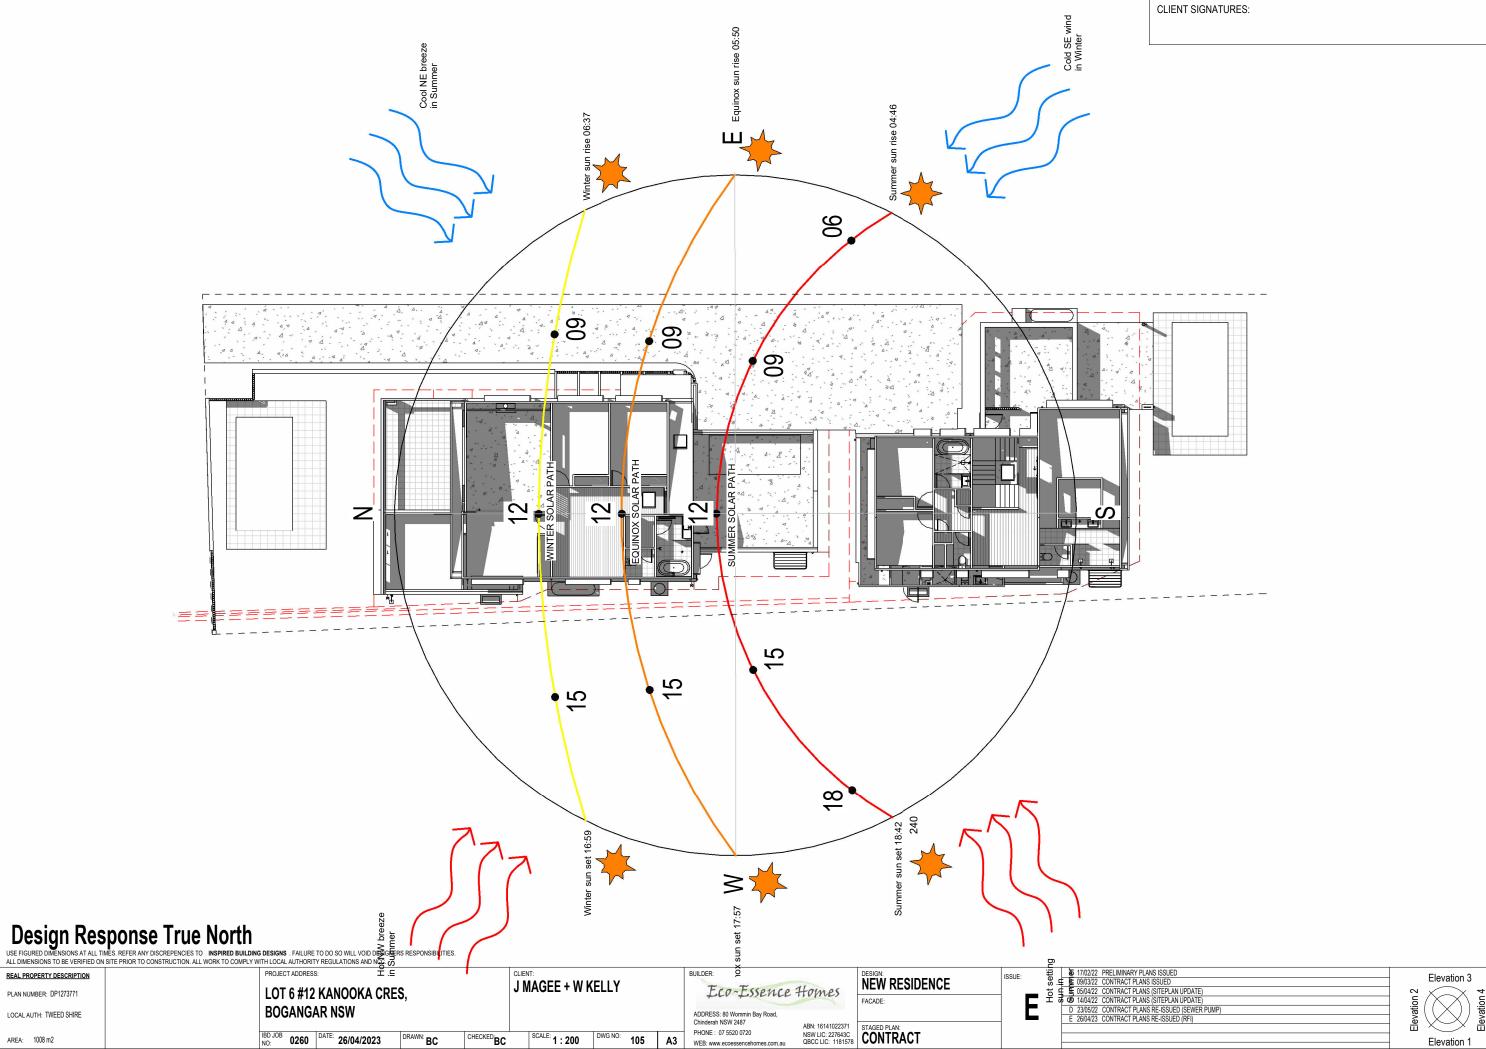



THIS DESIGN IN PART OR WHOLE IS SUBJECT TO COPYRIGHT © ECO ESSENCE HOMES

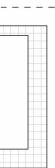


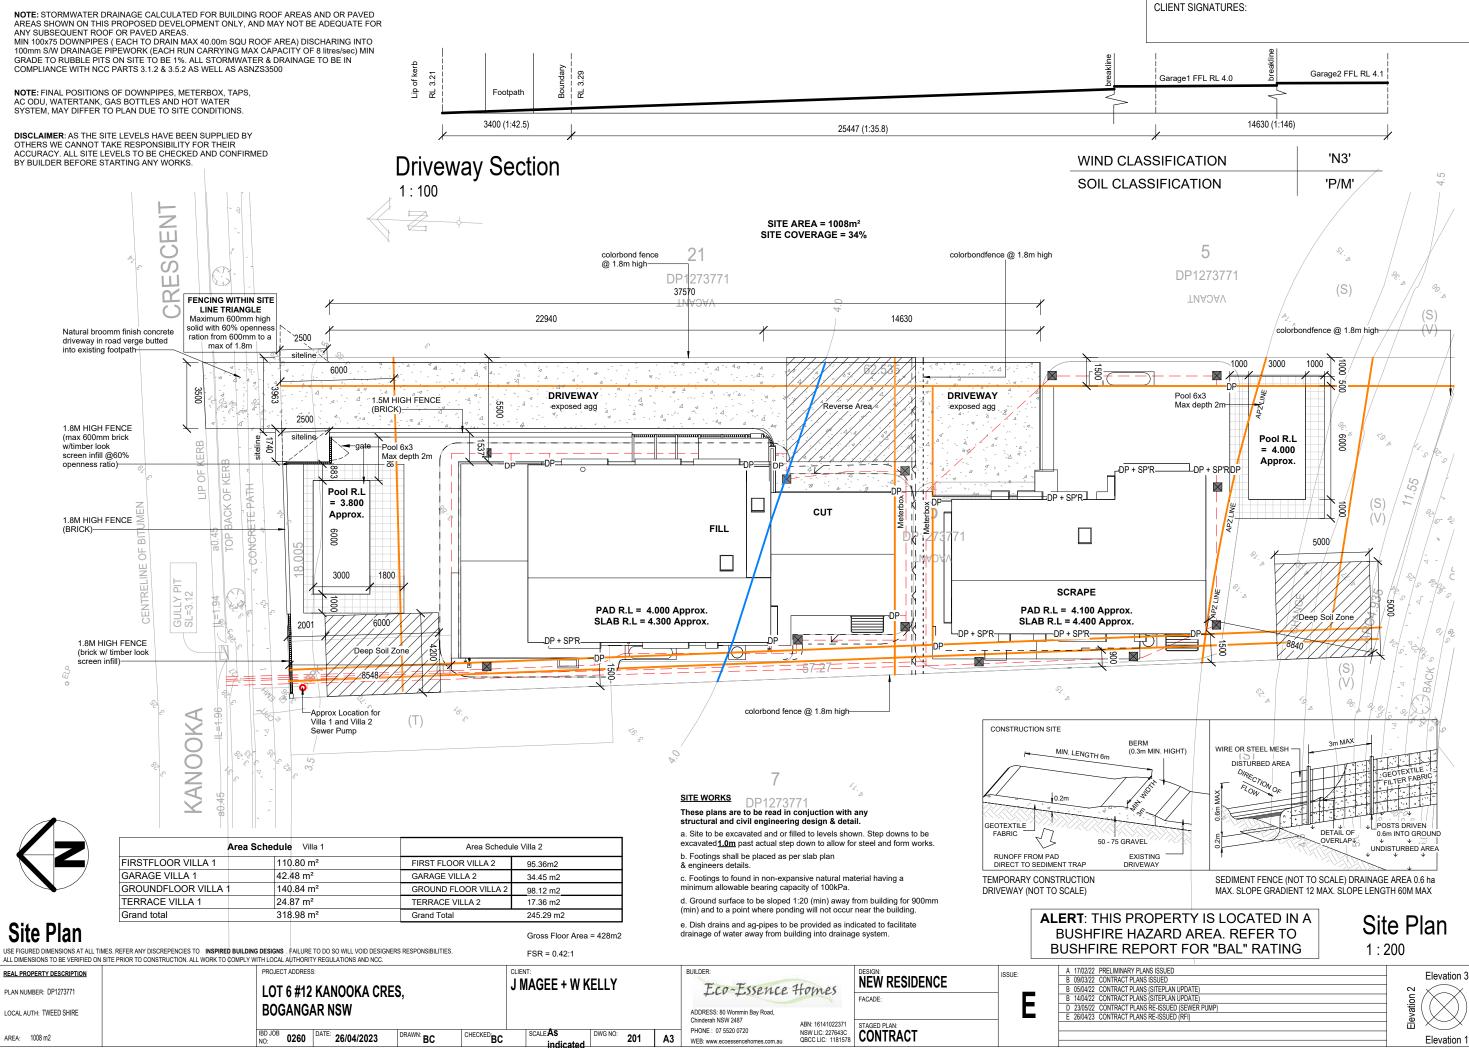

HIS DESIGN IN PART OR WHOLE IS SUBJECT TO COPYRIGHT © ECO ESSENCE HOMES

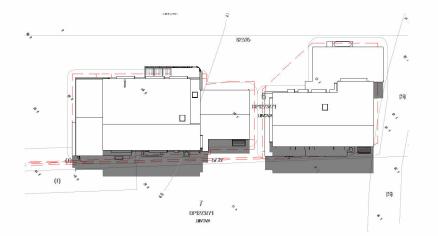

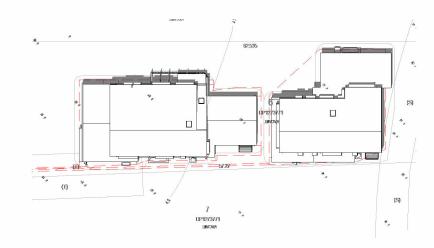


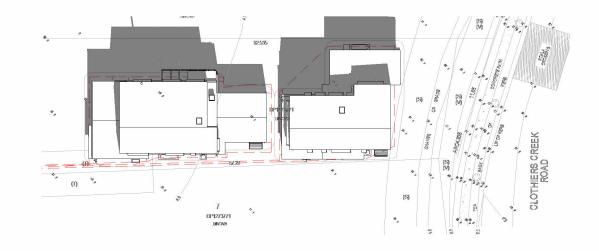



Dec 22nd 9am 1 : 500

Dec 22nd 12pm 1:500

Dec 22nd 3pm 1:500

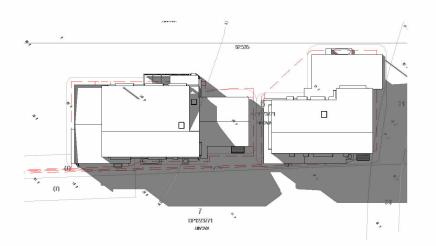

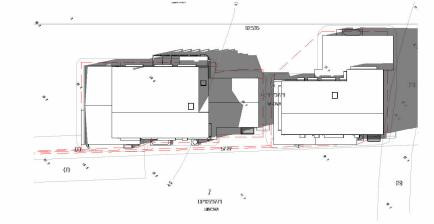

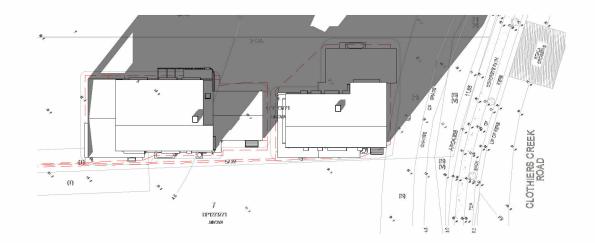

June 22nd 9am 1 : 500


June 22nd 12pm

June 22nd 3pm

Shadow Diagrams Use Figured Dimensions at all times, refer any discrepencies to Inspired Building designs. Failure to do so will void designers responsibilities

ALL DIMENSIONS TO BE VERIFIED ON	SITE PRIOR TO CONSTRUCTION. ALL WORK TO COMPLY WITH LC	JCAL AUTHORITY REGULATIONS AND NCC.										
REAL PROPERTY DESCRIPTION	PRC	DJECT ADDRESS:			CLIENT:			BUILDER:		DESIGN:	ISSUE:	A 17/02/22 PRELIMINARY PLANS ISSUED
					J MAGEE + W P					NEW RESIDENCE	1000 <u>E</u> .	B 09/03/22 CONTRACT PLANS ISSUED
PLAN NUMBER: DP1273771		OT 6 #12 KANOOKA CR	ES.					Eco-Essence:	Homes			B 05/04/22 CONTRACT PLANS (SITEPLAN UPDATE)
									all	FACADE:		B 14/04/22 CONTRACT PLANS (SITEPLAN UPDATE)
LOCAL AUTH: TWEED SHIRE	B(	OGANGAR NSW						ADDRESS: 80 Wommin Bay Road,				D 23/05/22 CONTRACT PLANS RE-ISSUED (SEWER
	-	••••••••						Chinderah NSW 2487	ABN: 16141022371			E 26/04/23 CONTRACT PLANS RE-ISSUED (RFI)
	IBD J		DDAMAN	OUFOVED	SCALE:	DWG NO:		PHONE : 07 5520 0720				
AREA: 1008 m2	NO:	0260 DATE: 26/04/2023	DRAWN: BC	CHECKED	SCALE: 1:500	DWG NO: 202	2 A3	WEB: www.ecoessencehomes.com.au	QBCC LIC: 1181578	CONTRACT		
THIS DESIGN IN PART OR WHOLE IS SUB	JECT TO COPYRIGHT © ECO ESSENCE HOMES	1	1	1	1			1				<u>.</u>



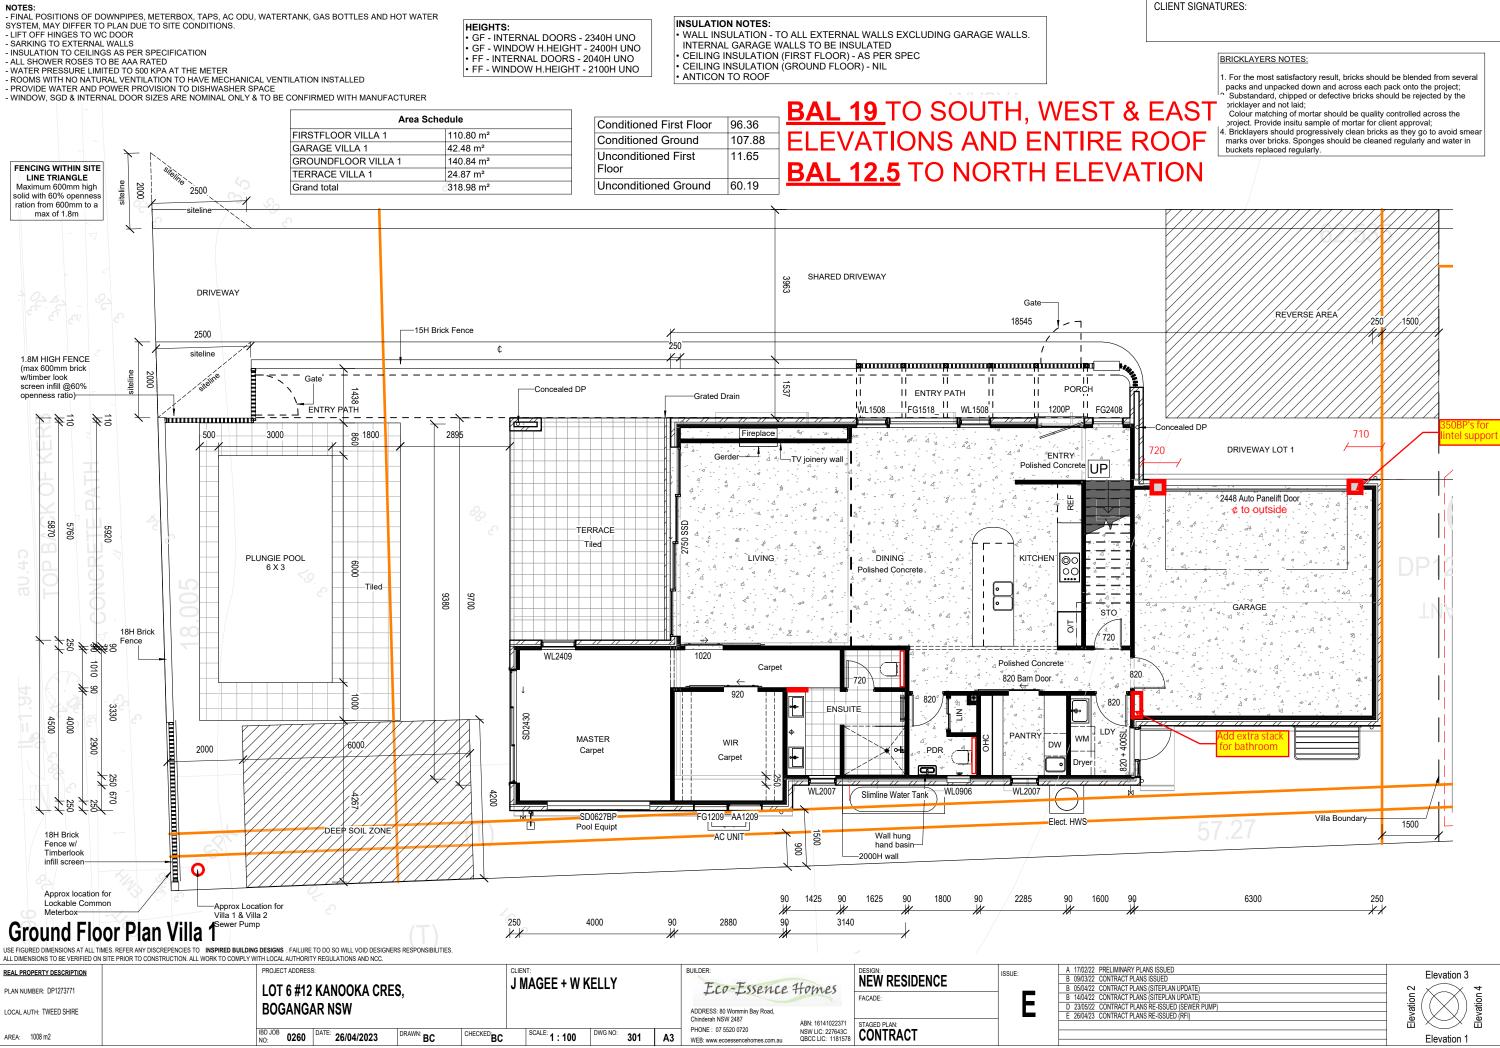

HIS DESIGN IN PART OR WHOLE IS SUBJECT TO COPYRIGHT © ECO ESSENCE HOMES

NOTE: THE POSITIONING OF ALL BULKHEADS AND AIR CONDITIONING DUCTING IS TO BE DETERMAINED ON SITE. LOCATIONS SHOWN ARE INDICATIVE ONLY. AIR-CON CONDENSER UNIT IN ROOF SPACE. STRENGTHEN ROOF FRAME TO SUIT

PROTECTION OF OPENABLE WINDOWS: OPENING WINDOWS IN BEDROOMS AT 2.0m OR MORE ABOVE THE SURFACE BELOW ARE TO BE FITTED WITH EITHER A DEVICE TO RESTRICT THE WINDOW OPENING, OR A SUITABLE SCREEN, SO A 125mm DIAMETER SPHERE CANNOT PASS THROUGH. THE SCREEN OR DEVICE MUST ALSO BE ABLE TO WITHSTAND AN OUTWARD HORIZONTAL FORCE OF 250 N.

-AWNING WINDOWS TO HAVE SHORT CHAIN WINDERS TO RESTRICT OPENING -SLIDING WINDOWS TO HAVE KEY LOCKS TO RESTRICT OPENING









### **First Floor Plan Villa 1**


USE FIGURED DIMENSIONS AT ALL TIMES. REFER ANY DISCREPENCIES TO INSPIRED BUILDING DESIGNS. FAILURE TO DO SO WILL VOID DESIGNERS RESPONSIBILITIES. ALL DIMENSIONS TO BE VERIFIED ON SITE PRIOR TO CONSTRUCTION. ALL WORK TO COMPLY WITH LOCAL AUTHORITY REGULATIONS AND NCC.


REAL PROPERTY DESCRIPTION	PROJECT ADDRESS:		CLIENT:			BUILDER:	DESIGN:		ISSUE:	A 17/02/22 PRELIMINARY PLANS ISSUED	
			J MAGEE + W K				NFW	V RESIDENCE	1000L.	B 09/03/22 CONTRACT PLANS ISSUED	
PLAN NUMBER: DP1273771	LOT 6 #12 KANOOKA CRES.					Eco-Essence Hom	es	TREOBENOL	_	B 05/04/22 CONTRACT PLANS (SITEPLAN UPDATE)	
							FACADE:	E:		B 14/04/22 CONTRACT PLANS (SITEPLAN UPDATE)	
LOCAL AUTH: TWEED SHIRE	BOGANGAR NSW					ADDRESS: 80 Wommin Bay Road.				D 23/05/22 CONTRACT PLANS RE-ISSUED (SEWER	
						Chinderah NSW 2487	44000074			E 26/04/23 CONTRACT PLANS RE-ISSUED (RFI)	
	IBD JOB DATE: DATE: DRAWN:	01/50//55		DWC NO.		PHONE : 07 5520 0720 ABN: 1614 NSW LIC:					
AREA: 1008 m2	IBD JOB 0260 DATE: 26/04/2023 DRAWN:	BC CHECKED BC	SCALE: 1:100	DWG NO: 302	A3	WEB: www.eccessencehomes.com.au QBCC LIC.	C: 1181578 CON	NTRACT			
	NO	20 20				WED. WWW.cooc3chochomes.com.au					
THIS DESIGN IN PART OR WHOLE IS SUBJECT TO COPYRIGHT © ECO ESSENCE HOMES											

INSULATION NOTES: • WALL INSULATION - TO ALL EXTERNAL WALLS EXCLUDING GARAGE INTERNAL GARAGE WALLS TO BE INSULATED • CEILING INSULATION (FIRST FLOOR) - AS PER SPEC • CEILING INSULATION (GROUND FLOOR) - NIL ANTICON TO ROOF

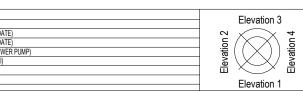

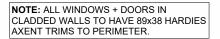

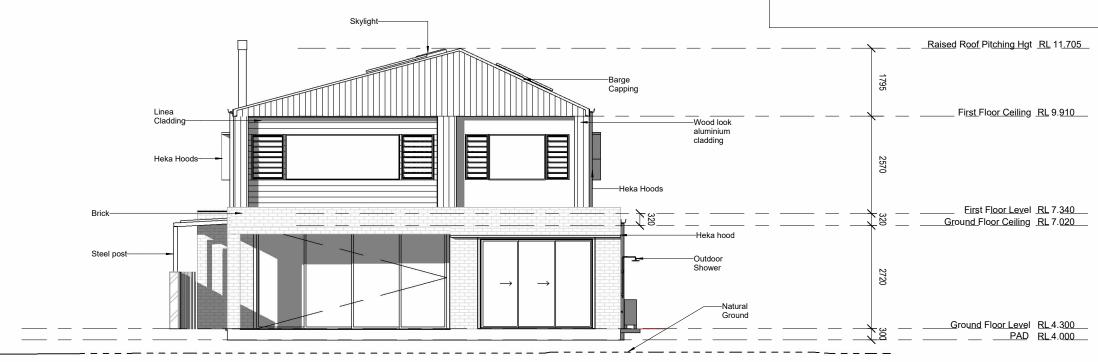

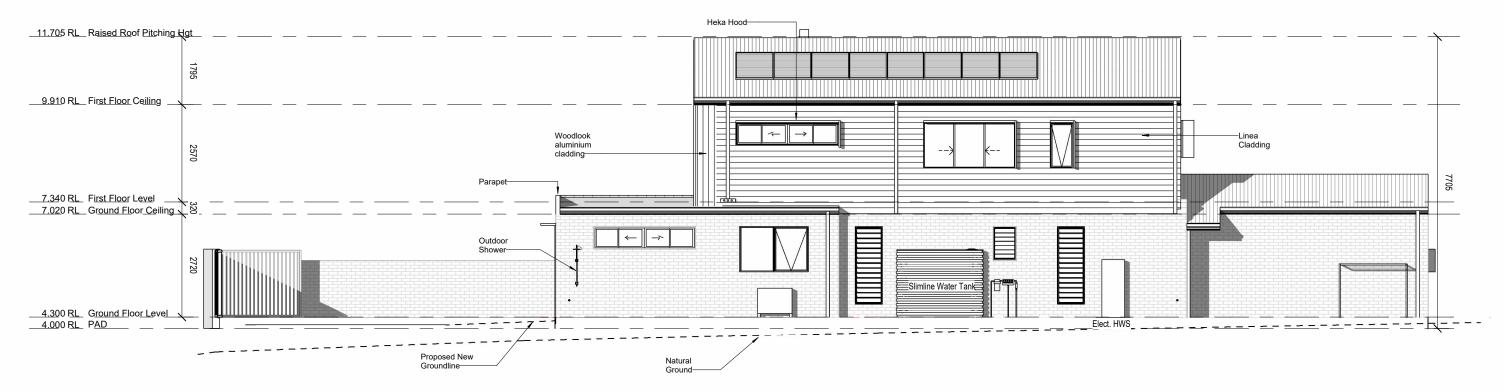


## **Elevations Villa 1**

USE FIGURED DIMENSIONS AT ALL TIMES. REFER ANY DISCREPENCIES TO INSPIRED BUILDING DESIGNS . FAILURE TO DO SO WILL VOID DESIGNERS RESPONSIBILITIES. ALL DIMENSIONS TO BE VERIFIED ON SITE PRIOR TO CONSTRUCTION. ALL WORK TO COMPLY WITH LOCAL AUTHORITY REGULATIONS AND NCC.


REAL PROPERTY DESCRIPTION	PROJECT ADDRESS:	CLIENT:	BUILDER:	DESIGN: ISSUE:	A 17/02/22 PRELIMINARY PLANS ISSUED						
		J MAGEE + W KELLY		NEW RESIDENCE	B 09/03/22 CONTRACT PLANS ISSUED						
PLAN NUMBER: DP1273771	LOT 6 #12 KANOOKA CRES.		Eco-Essence Homes		B 05/04/22 CONTRACT PLANS (SITEPLAN UPDATE)						
	,			FACADE:	B 14/04/22 CONTRACT PLANS (SITEPLAN UPDATE)						
LOCAL AUTH: TWEED SHIRE	BOGANGAR NSW		ADDRESS: 80 Wommin Bay Road,		D 23/05/22 CONTRACT PLANS RE-ISSUED (SEWER I						
LOCAL AUTH: TWEED SHIRE			Chinderah NSW 2487		E 26/04/23 CONTRACT PLANS RE-ISSUED (RFI)						
			ABN: 16141022371	STAGED PLAN:							
AREA: 1008 m2	IBD JOB 0260 DATE: 26/04/2023 DRAWN: BC CHECKED: BC	SCALE: 1:100 DWG NO: 303 A3	1000 2210400	CONTRACT							
		1.100 000 A3	WEB: www.ecoessencehomes.com.au QBCC LIC: 1181578	••••••••							


THIS DESIGN IN PART OR WHOLE IS SUBJECT TO COPYRIGHT © ECO ESSENCE HOMES

## Elevation 4 (West) 1:100

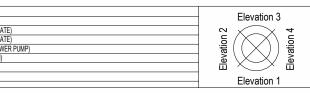

CLIENT SIGNATURES:

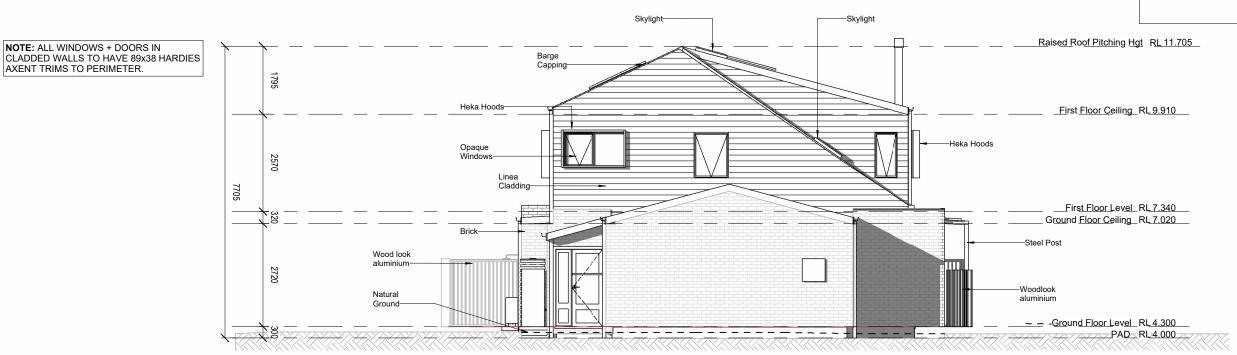

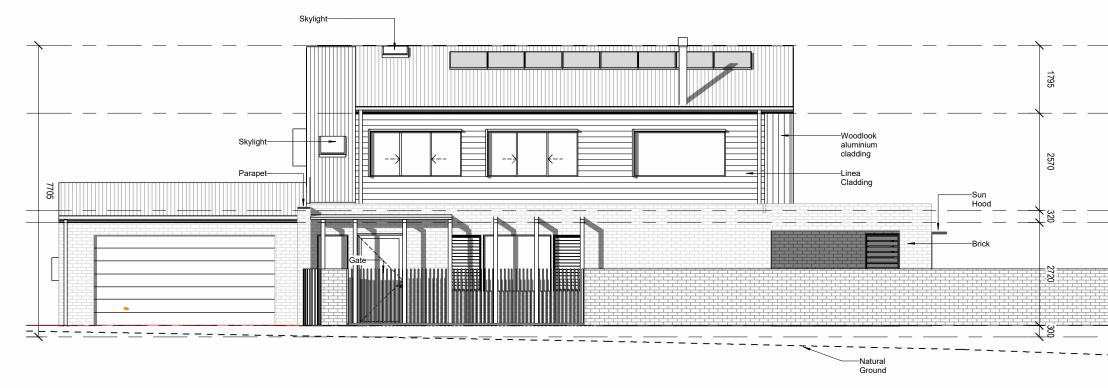

## **Elevations Villa 1**

USE FIGURED DIMENSIONS AT ALL TIMES, REFER ANY DISCREPENCIES TO INSPIRED BUILDING DESIGNS . FAILURE TO DO SO WILL VOID DESIGNERS RESPONSIBILITIES. ALL DIMENSIONS TO BE VERIFIED ON SITE PRIOR TO CONSTRUCTION. ALL WORK TO COMPLY WITH LOCAL AUTHORITY REGULATIONS AND NCC.

PROPERTY DESCRIPTION	PROJECT ADDRESS:	CLIENT:	BUILDER:	DESIGN:	ISSUE:	A 17/02/22 PRELIMINARY PLANS ISSUED				
		J MAGEE + W KELLY		NEW RESIDENCE	1000L.	B 09/03/22 CONTRACT PLANS ISSUED				
NUMBER: DP1273771	LOT 6 #12 KANOOKA CRES.		Eco-Essence Homes			B 05/04/22 CONTRACT PLANS (SITEPLAN UPDATE)				
				FACADE:		B 14/04/22 CONTRACT PLANS (SITEPLAN UPDATE)				
AUTH: TWEED SHIRE	BOGANGAR NSW		ADDRESS: 80 Wommin Bay Road,			D 23/05/22 CONTRACT PLANS RE-ISSUED (SEWER				
			Chinderah NSW 2487			E 26/04/23 CONTRACT PLANS RE-ISSUED (RFI)				
		DIMO NO:								
1008 m2	IBD JOB NO:         0260         DATE:         26/04/2023         DRAWN:         BC         CHECKED:         BC	SCALE: 1:100 DWG NO: 304 A3	WEB: www.ecoessencehomes.com.au QBCC LIC: 1181578	CONTRACT						
			TED. WWW.coocoscilocitorilos.colli.au							

THIS DESIGN IN PART OR WHOLE IS SUBJECT TO COPYRIGHT © ECO ESSENCE HOMES



### Elevation 1 (South) 1:100


Raised Roof Pitching Hgt RL 11.705


First Floor Ceiling RL 9.910

First Floor Level RL 7.340 Ground Floor Ceiling RL 7.020



### Elevation 2 (East) 1:100

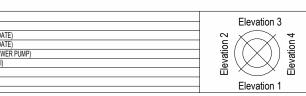

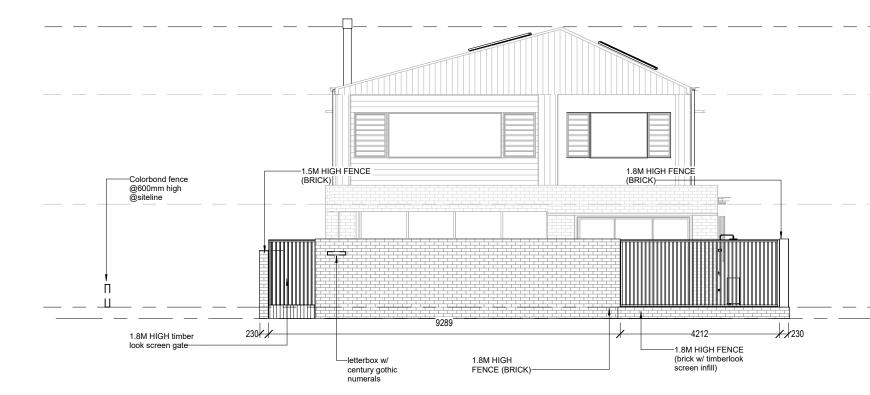


Front Fence Elevation Use Figured dimensions at all times. Refer any discrepencies to inspired building designs . Failure to do so will void designers responsibilities. All dimensions to be verified on site prior to construction all work to comply with local authority regulations and ncc.


REAL PROPERTY DESCRIPTION		PROJECT ADDRESS:		CLIENT:			BUILDER:		DESIGN:	ISSUE:	A 17/02/22 PRELIMINARY PLANS ISSUED
				J MAGEE + W P					NEW RESIDENCE	1000E.	B 09/03/22 CONTRACT PLANS ISSUED
PLAN NUMBER: DP1273771		LOT 6 #12 KANOOKA CRES,					Eco-Essence	Homes			B 05/04/22 CONTRACT PLANS (SITEPLAN UPDATE)
		,							FACADE:		B 14/04/22 CONTRACT PLANS (SITEPLAN UPDATE)
LOCAL AUTH: TWEED SHIRE		BOGANGAR NSW					ADDRESS: 80 Wommin Bay Road.				D 23/05/22 CONTRACT PLANS RE-ISSUED (SEWER)
LOCAL AOTH. TWEED STIRE							Chinderah NSW 2487				E 26/04/23 CONTRACT PLANS RE-ISSUED (RFI)
							PHONE: 07 5520 0720		STAGED PLAN:		
AREA: 1008 m2		IBD JOB 0260 DATE: 26/04/2023 DRAWN: BC	CHECKED	SCALE: 1:100	DWG NO: 30	4.2 A3	WEB: www.ecoessencehomes.com.au	NSW LIC: 227643C QBCC LIC: 1181578	CONTRACT		
	۲ ۲						WEB: www.ecoessencenomes.com.au	QD00 El0. 1101010	••••••		

THIS DESIGN IN PART OR WHOLE IS SUBJECT TO COPYRIGHT © ECO ESSENCE HOMES

CLIENT SIGNATURES:

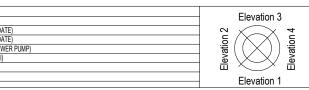

NOTES: - SELECTED ROOF FIXED IN ACCORDANCE WITH MANUFACTURERS SPECIFICATIONS - ROOF BATTENS FIXED IN ACCORDANCE WITH MANUFACTURERS SPECIFICATIONS - ROOF TRUSSES TO MANUFACTURERS SPECIFICATION - BRACING OF TRUSSES TO BE IN ACCORDANCE WITH MANUFACTURERS SPECIFICATIONS - ALL TIMBER SIZES TO CONFORM WITH NCC STANDARDS - SLAB & FOOTINGS TO ENGINEERS DETAIL - FLOORING MEMBERS TO ENGINEERS/MANUFACTURERS DETAIL

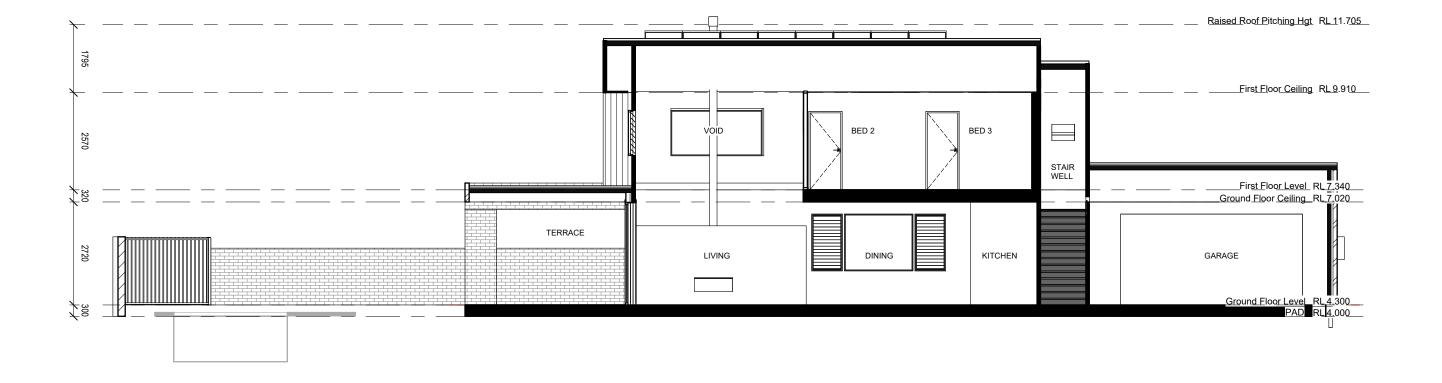

### Section


USE FIGURED DIMENSIONS AT ALL TIMES. REFER ANY DISCREPENCIES TO INSPIRED BUILDING DESIGNS . FAILURE TO DO SO WILL VOID DESIGNERS RESPONSIBILITIES. ALL DIMENSIONS TO BE VERIFIED ON SITE PRIOR TO CONSTRUCTION. ALL WORK TO COMPLY WITH LOCAL AUTHORITY REGULATIONS AND NCC.

REAL PROPERTY DESCRIPTION	PROJECT ADDRESS:	CLIENT:	BUILDER:	DESIGN:	ISSUE:	A 17/02/22 PRELIMINARY PLANS ISSUED				
		J MAGEE + W KELLY		NEW RESIDENCE	1000E.	B 09/03/22 CONTRACT PLANS ISSUED				
PLAN NUMBER: DP1273771	LOT 6 #12 KANOOKA CRES.		Eco-Essence Homes			B 05/04/22 CONTRACT PLANS (SITEPLAN UPDATE)				
	,			FACADE:		B 14/04/22 CONTRACT PLANS (SITEPLAN UPDATE)				
LOCAL AUTH: TWEED SHIRE	BOGANGAR NSW		ADDRESS: 80 Wommin Bay Road,			D 23/05/22 CONTRACT PLANS RE-ISSUED (SEWER)				
LOCAL AUTH. TWILLD STITLE	Boontontint		Chindomh NRW 2497			E 26/04/23 CONTRACT PLANS RE-ISSUED (RFI)				
			ABN: 161410223/1	STAGED PLAN:						
AREA: 1008 m2	IBD JOB NO:         0260         DATE:         26/04/2023         DRAWN:         BC         CHECKED BC	SCALE: 1:100 DWG NO: 305 A3	1000 Eld. 2270400	CONTRACT						
		1.100 300 A3	WEB: www.ecoessencehomes.com.au QBCC LIC: 11815/8	•••••••						

THIS DESIGN IN PART OR WHOLE IS SUBJECT TO COPYRIGHT © ECO ESSENCE HOMES




COLC

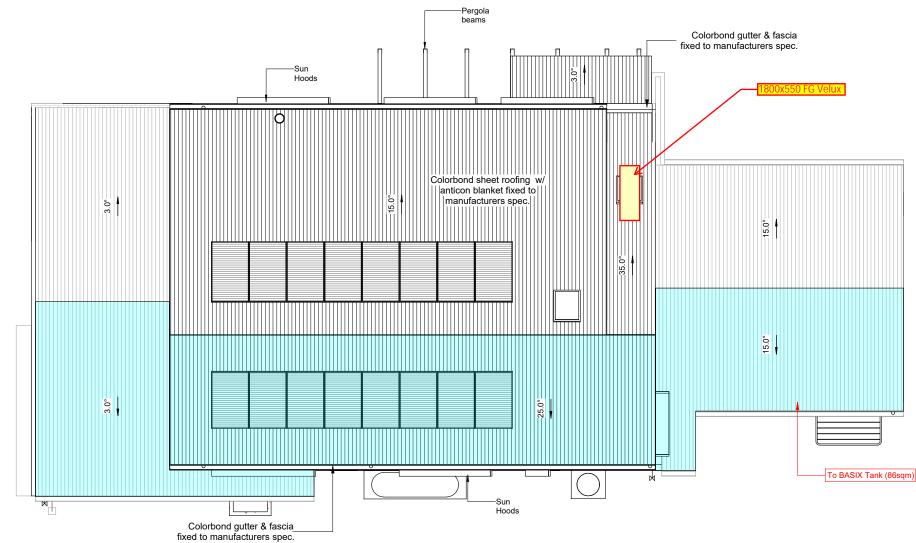

Upper Roof Plan Villa 1 Use Figured dimensions at all times. Refer any discrepencies to inspired building designs . Failure to do so will void designers responsibilities. All dimensions to be verified on site prior to construction. All work to comply with local authority regulations and ncc.


REAL PROPERTY DESCRIPTION	PROJECT ADDRESS:	CLIENT:	BUILDER:	DESIGN:	ISSUE:	A 17/02/22 PRELIMINARY PLANS ISSUED
		J MAGEE + W KELLY		NEW RESIDENCE	1000L.	B 09/03/22 CONTRACT PLANS ISSUED
PLAN NUMBER: DP1273771	LOT 6 #12 KANOOKA CRES.		Eco-Essence Homes			B 05/04/22 CONTRACT PLANS (SITEPLAN UPDATE)
	,		per printe miner	FACADE:		B 14/04/22 CONTRACT PLANS (SITEPLAN UPDATE)
LOCAL AUTH: TWEED SHIRE	BOGANGAR NSW		ADDRESS: 80 Wommin Bay Road,			D 23/05/22 CONTRACT PLANS RE-ISSUED (SEWER)
LOCAL AUTH: TWEED SHIRE			Chindersh NSW 2487			E 26/04/23 CONTRACT PLANS RE-ISSUED (RFI)
			ABN: 16141022371	STAGED PLAN:		
AREA: 1008 m2	IBD JOB 0260 DATE: 26/04/2023 DRAWN: BC CHECKED BC	SCALE: 1:100 DWG NO: 311 A3	0000110_1101570	CONTRACT		
	NO: 0200 20/04/2023 BC BC	1.100 JII AJ	WEB: www.ecoessencehomes.com.au QBCC LIC: 1181578			
THIS DESIGN IN PART OR WHOLE IS SUBJECT TO COPYRIGHT © ECO ESSENCE HOMES						


Main Roof Schedule							
Type Area							
LORBOND SHEET ROOF	221.273M2						

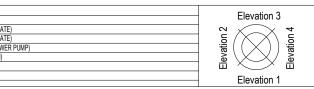



)	Elevation 3
	Licvation 5
N UPDATE)	
N UPDATE)	Elevation
ED (SEWER PUMP)	afi(X))afi [
ED (RFI)	
· ·	
	Elevation 1

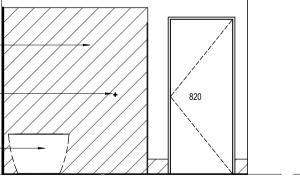

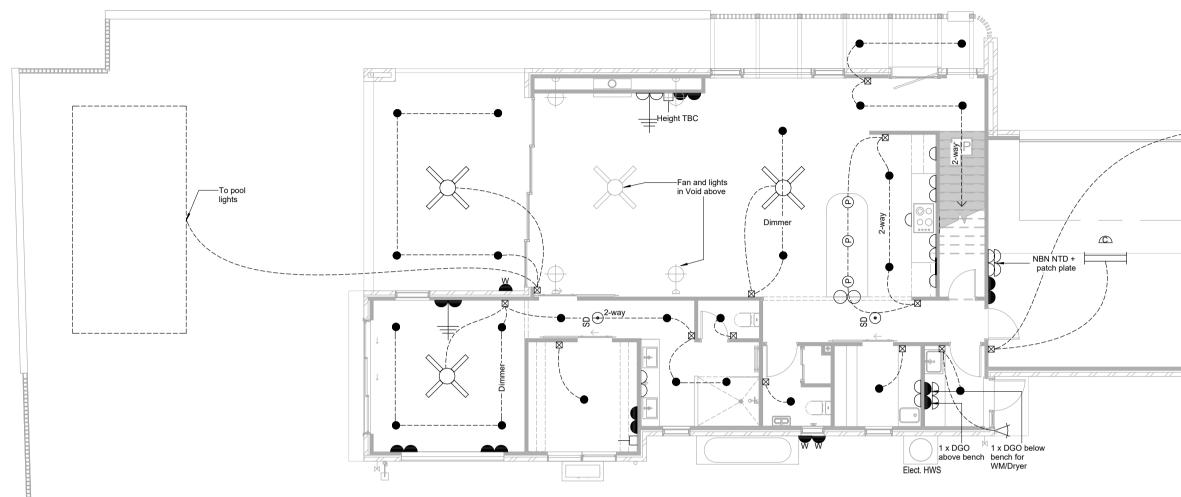



## **Electrical Plan - Ground Floor**

USE FIGURED DIMENSIONS AT ALL TIMES. REFER ANY DISCREPENCIES TO INSPIRED BUILDING DESIGNS. FAILURE TO DO SO WILL VOID DESIGNERS RESPONSIBILITIES. ALL DIMENSIONS TO BE VERIFIED ON SITE PRIOR TO CONSTRUCTION. ALL WORK TO COMPLY WITH LOCAL AUTHORITY REGULATIONS AND BCA. ANY 3D PERSPECTIVES ARE FOR ILLUSTRATION PURPOSES ONLY.

REAL PROPERTY DESCRIPTION	PROJECT ADDRESS:	CLIENT:	PROJECT:	ISSUE:	A 17/02/22 PRELIMINARY PLANS ISSUED	Elevation 3
PLAN NUMBER: DP1273771	LOT 6 #12 KANOOKA CRES,	J MAGEE + W KELLY	NEW RESIDENCE		B 09/03/22 CONTRACT PLANS ISSUED B 05/04/22 CONTRACT PLANS (SITEPLAN UPDATE) B 14/04/22 CONTRACT PLANS (SITEPLAN UPDATE)	
LOCAL AUTH: TWEED SHIRE	BOGANGAR NSW	BUILDER:	STAGED PLAN: CONTRACT		D 23/05/22 CONTRACT PLANS (STEPLAN OPDATE) D 23/05/22 CONTRACT PLANS RE-ISSUED (SEWER PUMP) E 26/04/23 CONTRACT PLANS RE-ISSUED (RFI)	Elevatio
AREA: 1008 m2	DWG NO: DATE: 26/04/2023	DRAWN: BC CHECKED: BC JOB NO: 0260 THIS DES	IGN IN PART OR WHOLE IS SUBJECT TO COPYRIGHT © I NSPIRED BUILDING DESIGNS	A3		Elevation 1



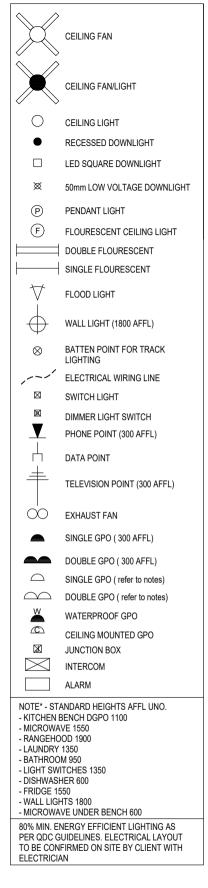


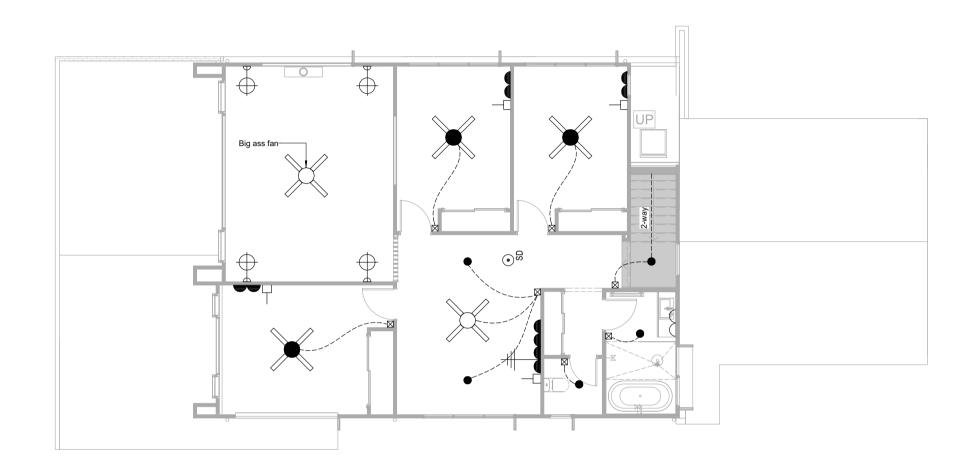

## Electrical Plan - First Floor

USE FIGURED DIMENSIONS AT ALL TIMES. REFER ANY DISCREPENCIES TO INSPIRED BUILDING DESIGNS . FAILURE TO DO SO WILL VOID DESIGNERS RESPONSIBILITIES. ALL DIMENSIONS TO BE VERIFIED ON SITE PRIOR TO CONSTRUCTION. ALL WORK TO COMPLY WITH LOCAL AUTHORITY REGULATIONS AND BCA. ANY 3D PERSPECTIVES ARE FOR ILLUSTRATION PURPOSES ONLY.

REAL PROPERTY DESCRIPTION	PROJECT ADDRESS:	CLIENT:	PROJECT:	ISSUE:	A 17/02/22 PRELIMINARY PLANS ISSUED B 09/03/22 CONTRACT PLANS ISSUED	Elevation 3
PLAN NUMBER: DP1273771	LOT 6 #12 KANOOKA CRES,	J MAGEE + W KELLY	NEW RESIDENCE		B 05/03/22 CONTRACT PLANS (SITEPLAN UPDATE) B 14/04/22 CONTRACT PLANS (SITEPLAN UPDATE) B 14/04/22 CONTRACT PLANS (SITEPLAN UPDATE)	n 2 1 2
LOCAL AUTH: TWEED SHIRE	BOGANGAR NSW	BUILDER:	STAGED PLAN: CONTRACT	] <b>E</b>	E 14/04/22 CONTRACT PLANS (STEPLAN OFDATE) D 23/05/22 CONTRACT PLANS RE-ISSUED (SEVER PUMP) E 26/04/23 CONTRACT PLANS RE-ISSUED (RFI)	levatio
AREA: 1008 m2	DWG NO:802 SCALE: 1 : 100 DATE: 26/04/2023	L DRAWN:BC CHECKED:BC JOB NO: 0260 THIS DESIGN	IN PART OR WHOLE IS SUBJECT TO COPYRIGHT © I NSPIRED BUILDING DESIGNS A3	-		ш С ш Elevation 1

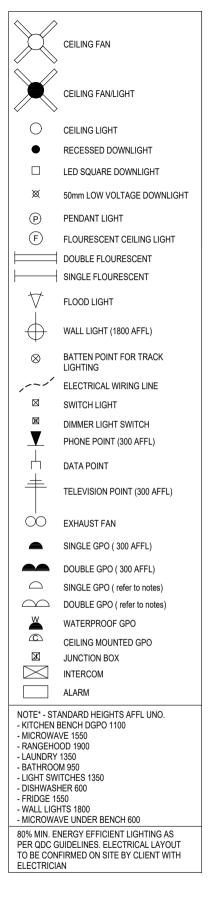



Project summary		
Project name	Lot6Kanooka	
Street address	12 Kanooka Crescent	BOGANGAR 2488
Local Government Area	Tweed Shire Council	
Plan type and plan number	deposited 1273771	
Lot no.	6	
Section no.	(=);	
No. of residential flat buildings	0	
No. of units in residential flat buildings	0	
No. of multi-dwelling houses	2	
No. of single dwelling houses	0	
Project score		
Water	43	Target 40
Thermal Comfort	V Pass	Target Pass
Energy	100	Target 50

<section-header><section-header><section-header></section-header></section-header></section-header>	uilding Sustainability Index www.basix.nsw.gov.au		summary							
<section-header></section-header>		Project na		NO 1010 M						
	ulti Dwelling									
	ulti Dwelling		Calculation and the second sec		A PARTICIPATION PROPERTY AND A PARTICIPATION OF A P	Description of	of project			
							5 S 45 S 30 4 C 7 5 5			
	difeste number: 1280260M		and plan number	deposited 1273771						
	unoate (1011061, 120320310			6		Project address		Common area landscape		
	s certificate confirms that the proposed development will me			-			Lot6Kanooka		0.0	
	vernment's requirements for sustainability, if it is built in acco	ordance with the						-		
		in the communication			-			Area of indigenous or low water use	1.5.2	
	9/2020 published by the Department. This document is available	vailable at				Plan type and plan number		species (m²)	200.000	
		NO. OF SING	16	V			6	Assessor details	W	
	relary		score			Section no.		Assessor number	HERA10135	
	te of issue: Monday, 23 May 2022	VP SYALVER AV		43	Target 40	Project type		Certificate number	0007157688-01	
	e valid, this certificate must be lodged within 3 months of the date		Comfort	Pass	Tarpet Pass		0		- A 4.4.4.5	
	Mit.   Planning				i si got i aas		0		2	
	industry &	Energy		100	Target 50	No. of multi-dwelling houses	2	<ul> <li>Ceiling fan in at least one living room or other conditioned area</li> </ul>	Yes	
	MA I Environment					No. of single dwelling houses	0			
						Site details				1000 and the set
						Site area (m²)	1008	vrater	✔ 43	Target 40
						Roof area (m <sup>2</sup> )	339.81	Thermal Comfort	V Pass	Target Pass
						Non-residential floor area (m <sup>2</sup> )	0.0		20000000	1204 1303
						Residential car spaces	4	Energy	✓ 100	Target 50
		Certific	ate Prepared by			Non-residential car spaces	0			
								-		
		Name / Cr	impany Name: Eco Essence Ho	mes						
•••••••••••••••••••••••••••••		ABN (if ap	plicable): 16141022371							
AdX       Penning Industry & Environment       www.tasist.mes.gov.au       Venice: 3d / DARWING, 3, 2d, 9       Certificate No: 1280208M       Monday, 23 May 2022         AdX       Penning Industry & Environment       www.tasist.mes.gov.au       Venice: 3d / DARWING, 3, 2d, 9       Certificate No: 1280208M       Monday, 23 May 2022         AdX       Penning Industry & Environment       www.tasist.mes.gov.au       Venice: 3d / DARWING, 3, 2d, 9       Certificate No: 1280208M       Monday, 23 May 2022         AdX       Penning Industry & Environment       www.tasist.mes.gov.au       Venice: 3d / DARWING, 3, 2d, 9       Certificate No: 1280208M       Monday, 23 May 2022         AdX       Penning Industry & Environment       Wenice: 1280208M       Monday, 23 May 2022       Page 3rd       BASK       Penning Industry & Environment       Wenice: 3d / DARWING, 3, 2d, 9       Certificate No: 1280208M       Monday, 23 May 2022         AdX       Description of the Science of the Sc	The tables below describe the dwellings and common an	reas within the project (m) server species area m*)				1. Commitments for multi-dwelling t (a) Dwellings (i) Water (ii) Energy				
NNS AT ALL TIMES. REFER ANY DISCREPENCIES TO INSPIRED BUILDING DESIGNS . FAILURE TO DO SO WILL ONSIBILITIES. ALL DIMENSIONS TO BE VERIFIED ON SITE PRIOR TO CONSTRUCTION. ALL WORK TO COMPLY Y REGULATIONS AND BCA. ANY 3D PERSPECTIVES ARE FOR ILLUSTRATION PURPOSES ONLY. NPTION  PROJECT ADDRESS:  CLIENT: IMACEE I W/KEILV  PROJECT: IMACEE I W/KEILV  REW DESIDENCE  ISSUE: A 17/02/22 PRELIMINARY PLANS ISSUED B 09/03/22 CONTRACT PLANS ISSUED B 09/03/22 CONTRACT PLANS ISSUED	or or	esy Bipu 165.0 0.0				<ol> <li>Commitments for single dwelling</li> <li>Commitments for common areas (i) Water</li> </ol>		ent (non-building specific)		
	of of more	650 0.0				<ol> <li>Commitments for single dwelling</li> <li>Commitments for common areas (i) Water</li> </ol>		ent (non-building specific)		
	of more bedrooms       of more bedrooms         BASIX       Planning, Industry & Environment       www.basix.nsw.gov.au         BASIX       Planning, Industry & Environment       www.basix.nsw.gov.au         ALL TIMES, REFER ANY DISCREPENCIES TO LITIES. ALL DIMENSIONS TO BE VERIFIED ON SITE PRIOR TO CONSTRUCTION. AL ILATIONS AND BCA. ANY 3D PERSPECTIVES ARE FOR ILLUSTRATION PURPOSES	Version: 3.0 / DARWINIA_3_20_0	CLIENT:		100	2. Commitments for single dwelling 3. Commitments for common areas (i) Water (ii) Energy BASIX Planning. Industry & Environment	and central systems/facilities for the developme	5.20.0 Certificate No.: 1289269M A 17/02/22 PRELIMINARY PLANS ISSUED B 09/03/22 CONTRACT PLANS ISSUED		
	BASIX Planning, Industry & Environment www.basix.nsw.gov.au ALL TIMES. REFER ANY DISCREPENCIES TO INSPIRED BUILDING DESIGNS . FA LITIES. ALL DIMENSIONS TO BE VERIFIED ON SITE PRIOR TO CONSTRUCTION AL ILATIONS AND BCA. ANY 3D PERSPECTIVES ARE FOR ILLUSTRATION PURPOSES A PROJECT ADI	Version: 3.0 / DARWIN(A, 3, 20, 0 AILURE TO DO SO WILL LLWORK TO COMPLY S ONLY. JDRESS:	CLIENT:		100	2. Commitments for single dwelling 3. Commitments for common areas (i) Water (ii) Energy BASIX Planning, Industry & Environment	and central systems/facilities for the developme	3_20_0 Certificate No:: 1289269M A 17/02/22 PRELIMINARY PLANS ISSUED B 09/03/22 CONTRACT PLANS ISSUED B 05/04/22 CONTRACT PLANS (STEPLAN UPE	DATE)	
IRE BOGANGAR NSW DOLLAR: CONTRACT PLANS RE-ISSUED (SEWER PUMP) E 26/04/23 CONTRACT PLANS RE-ISSUED (SEWER PUMP) E 26/04/23 CONTRACT PLANS RE-ISSUED (RFI)	BASIX Planning, Industry & Environment www.basix.new.gov.au ALL TIMES. REFER ANY DISCREPENCIES TO INSPIRED BUILDING DESIGNS . TA LALL DIMENSIONS TO BE VERIFIED ON SITE PRIOR TO CONSTRUCTION AL LALTONS AND DISCA. ANY 3D PERSPECTIVES ARE FOR ILLUSTRATION PURPOSES A	Version: 3.0 / DARWINIA_3_20_0 ALLURE TO DO SO WILL LL WORK TO COMPLY SONLY. JORRESS: #12 KANOOKA CRES,	CLIENT: J MAGEE + V		100	2. Commitments for single dwelling 3. Commitments for common areas (i) Water (ii) Energy BASIX Planning, Industry & Environment PROJECT: NEW RESIDENCE	and central systems/facilities for the developments www.basik.rese.gov.au Version: 3.0 / DARWINIA_	A 17/02/22 PRELIMINARY PLANS ISSUED     B 09/03/22 CONTRACT PLANS ISSUED     B 09/03/22 CONTRACT PLANS ISSUED     B 14/04/29 CONTRACT PLANS ISSUED AN UPP	DATE)	P

Project address		Common area landscape
Project name	Lot6Kanooka	Common area lawn (m²)
Street address	12 Kanooka Crescent BOGANGAR 2488	Common area garden (m²)
Local Government Area	Tweed Shire Council	Area of indigenous or low water use
Plan type and plan number	deposited 1273771	species (m²)
Lot no.	6	Assessor details
Section no.		Assessor number
Project type		Certificate number
No. of residential flat buildings	0	Climate zone
No. of units in residential flat buildings	0	Ceiling fan in at least one bedroom
No. of multi-dwelling houses	2	Ceiling fan in at least one living room other conditioned area
No. of single dwelling houses	0	Project score
Site details		Water
Site area (m²)	1008	water
Roof area (m <sup>2</sup> )	339.81	Thermal Comfort
Non-residential floor area (m <sup>2</sup> )	0.0	
Residential car spaces	4	Energy
Non-residential car snaces	0	



### Schedule of BASIX commitments

The commitments set out below regulate how the proposed development is to be carried out. It is a condition of any development consent granted, or complying development certificate issued, for the proposed development, that BASIX commitments be complied with.

### 1. Commitments for multi-dwelling houses

### (a) Dwellings

(i) Water	Show on DA plans	Show on CC/CDC plans & specs	Certifier check
(a) The applicant must comply with the commitments listed below in carrying out the development of a dwelling listed in a table below.	1		1
(b) The applicant must plant indigenous or low water use species of vegetation throughout the area of land specified for the dwelling in the "Indigenous species" column of the table below, as private landscaping for that dwelling. (This area of indigenous vegetation is to be contained within the "Area of garden and lawn" for the dwelling specified in the "Description of Project" table).	~	~	
(c) If a rating is specified in the table below for a fixture or appliance to be installed in the dwelling, the applicant must ensure that each such fixture and appliance meets the rating specified for it.		~	~
(d) The applicant must install an on demand hot water recirculation system which regulates all hot water use throughout the dwelling, where indicated for a dwelling in the "HW recirculation or diversion" column of the table below.	9 	~	~
(e) The applicant must install:			
(aa) a hot water diversion system to all showers, kitchen sinks and all basins in the dwelling, where indicated for a dwelling in the "HW recirculation or diversion" column of the table below; and		~	
(bb) a separate diversion tank (or tanks) connected to the hot water diversion systems of at least 100 litres. The applicant must connect the hot water diversion tank to all toilets in the dwelling.		~	~
(e) The applicant must not install a private swimming pool or spa for the dwelling, with a volume exceeding that specified for it in the table below.	~	~	
(f) If specified in the table, that pool or spa (or both) must have a pool cover or shading (or both).	8	~	
(g) The pool or spa must be located as specified in the table.	~	~	
(h) The applicant must install, for the dwelling, each alternative water supply system, with the specified size, listed for that dwelling in the table below. Each system must be configured to collect run-off from the areas specified (excluding any area which supplies any other alternative water supply system), and to divert overflow as specified. Each system must be connected as specified.	~	~	~

	Fixtures				App	liances		Individual pool				Individual spa		
Dwelling no.	Ali shower- heads	All toilet flushing systems	kitchen	All bathroom taps	HW recirculation or diversion	All clothes washers	All dish- washers	Volume (max volume)	Pool cover	Pool location	Pool shaded	Volume (max volume)	Spa cover	Spa shadeo
All dwellings	3 star (> 7.5 but <= 9 L/min)	4 star	4 star	5 star	no	1		21.0	no	outdoors	no	0.0	no	no

	Alternative water source										
Dwelling no.	Alternative water supply systems	Size	Configuration	Landscape connection	Toilet connection (s)	Laundry connection	Pool top-up	Spa top-up			
1	individual water tank (no. 1)	Tank size (min) 3000.0 litres	To collect run-off from at least: 80.0 square metres of roof area;	yes	yes	yes	yes	no			
All other dwellings	individual water tank (no. 2)	Tank size (min) 3000.0 litres	To collect run-off from at least: 80.0 square metres of roof area; 0.0 square metres of impervious area; 0.0 square metres of garden and lawn area; and 0.0 square metres of planter box area.	yes	yes	уөз	yes	no			

(ii) Energy	Show on DA plans	Show on CC/CDC plans & specs	Certifier check
(a) The applicant must comply with the commitments listed below in carrying out the development of a dwelling listed in a table below.	8		
(b) The applicant must install each hot water system specified for the dwelling in the table below, so that the dwelling's hot water is supplied by that system. If the table specifies a central hot water system for the dwelling, then the applicant must connect that central system to the dwelling, so that the dwelling's hot water is supplied by that central system.	~	~	~
(c) The applicant must install, in each bathroom, kitchen and laundry of the dwelling, the ventilation system specified for that room in the table below. Each such ventilation system must have the operation control specified for it in the table.	5	~	~

BASIX Planning, Industry & Environment www.basix.rsw.gov.au Version: 3.0 / DARWINIA, 3\_20\_0 Certificate No.: 1289269M

li) Energy	Show on DA plans	Show on CC/CDC plans & specs	Certifie check
(d) The applicant must install the cooling and heating system/s specified for the dwelling under the "Living areas" and "Bedroom areas" headings of the "Cooling" and "Heating" columns in the table below, in/for at least 1 living/bedroom area of the dwelling. If no cooling or heating system is specified in the table for "Living areas" or "Bedroom areas", then no systems may be installed in any such areas. If the term "zoned" is specified beside an air conditioning system, then the system must provide for day/night zoning between living areas and bedrooms.		~	
(e) This commitment applies to each room or area of the dwelling which is referred to in a heading to the "Artificial lighting" column of the table below (but only to the extent specified for that room or area). The applicant must ensure that the "primary type of artificial lighting" for each such room in the dwelling is fluorescent lighting or light emitting diode (LED) lighting. If the term "dedicated" is specified for a particular room or area, then the light fittings in that room or area must only be capable of being used for fluorescent lighting or light emitting diode (LED) lighting.	5	~	~
(f) This commitment applies to each room or area of the dwelling which is referred to in a heading to the "Natural lighting" column of the table below (but only to the extent specified for that room or area). The applicant must ensure that each such room or area is fitted with a window and/or skylight.	~	~	~
(g) This commitment applies if the applicant installs a water heating system for the dwelling's pool or spa. The applicant must:			
(aa) install the system specified for the pool in the "Individual Pool" column of the table below (or alternatively must not install any system for the pool). If specified, the applicant must install a timer, to control the pool's pump; and		<b>~</b>	
(bb) install the system specified for the spa in the "Individual Spa" column of the table below (or alternatively must not install any system for the spa). If specified, the applicant must install a timer to control the spa's pump.	2	~	,
(h) The applicant must install in the dwelling:			
(aa) the kitchen cook-top and oven specified for that dwelling in the "Appliances & other efficiency measures" column of the table below;		~	
(bb) each appliance for which a rating is specified for that dwelling in the "Appliances & other efficiency measures" column of the table, and ensure that the appliance has that minimum rating; and		~	~
(cc) any clothes drying line specified for the dwelling in the "Appliances & other efficiency measures" column of the table.		~	
(i) If specified in the table, the applicant must carry out the development so that each refrigerator space in the dwelling is "well ventilated".		<b>~</b>	
(j) The applicant must install the photovoltaic system specified for the dwelling under the "Photovoltaic system" heading of the "Alternative energy" column of the table below, and connect the system to that dwelling's electrical system.	~	~	~

Hot water	Hot water	Bathroom ven	tilation system	Kitchen ventilation system		
Dwelling no.	Hot water system	Each bathroom	Operation control	Each kitchen	Operation co	
1	electric heat pump - air sourced 21 to 25 STCs	individual fan, ducted to façade or roof	interlocked to light	individual fan, ducted to façade or roof	manual switcl	
All other dwellings	electric heat pump - air sourced 21 to 25 STCs	no mechanical ventilation (ie. natural)	2	individual fan, ducted to façade or roof	manual switcl	

Cooling		oling	Hea	ting	Artific				
Dwelling no.	living areas	bedroom areas	living areas	bedroom areas	No. of bedrooms &/or study	No. of living &/or dining rooms	Each kitchen	Ail bath toile	
All dwellings	1-phase airconditioning EER 3.0 - 3.5	1-phase airconditioning EER 3.0 - 3.5	1-phase airconditioning EER 3.5 - 4.0	1-phase airconditioning EER 3.5 - 4.0	4	3	уөз	yes	

	Individual pool		Individual spa		Appliances			
Dwelling no.	Pool heating system	Timer	Spa heating system	Timer	Kitchen cooktop/oven	Refrigerator	Well ventilated fridge space	Dishwa
All dwellings	no heating	yes	ē		induction cooktop & electric oven	•	no	Ĩ

	Alternal
Dwelling no.	Photovoltaic system (min rated electrical output in p
All dwellings	6.66

BASIX Planning, Industry & Environment www.basix.nsw.gov.au Version: 3.0 / DARWINIA\_3\_20\_0 Certificate No. 1289269M

# BASIX 02

Certificate No.: 1289269M Monday, 23 May 2022 page 8/13

 DASIX
 Planning, Industry & Environment
 Www.basix.nsw.gov.au
 Version: 3.0 / DARWINIA\_3\_20\_0

 Use Figured Dimensions at ALL TIMES. REFER ANY DISCREPENCIES TO
 INSPIRED BUILDING DESIGNS. FAILURE TO DO SO WILL
 Version: 3.0 / DARWINIA\_3\_20\_0

 Void DESIGNERS RESPONSIBILITIES. ALL DIMENSIONS TO BE VERIFIED ON SITE PRIOR TO CONSTRUCTION. ALL WORK TO COMPLY
 Version: 3.0 / DARWINIA\_3\_20\_0

REAL PROPERTY DESCRIPTION	PROJECT ADDR	ESS:	CLIENT:				PROJECT:		ISSUE:	A 17/02/22 PRELIMINARY PLANS ISSUED B 09/03/22 CONTRACT PLANS ISSUED
PLAN NUMBER: DP1273771	LOT 6 #1	2 KANOOKA CRES,	J MAGE	E + W KELLY			NEW RESIDENCE			B 05/04/22 CONTRACT PLANS (SITEPLAN
LOCAL AUTH: TWEED SHIRE		GAR NSW	BUILDER:						E	B 14/04/22 CONTRACT PLANS (SITEPLAN D 23/05/22 CONTRACT PLANS RE-ISSUED E 26/04/23 CONTRACT PLANS RE-ISSUED
							CONTRACT	_		E 20/04/23 CONTRACT PLANS RE-ISSUEL
AREA: 1008 m2	DWG NO. 903	SCALE: DATE: 26/	04/2023 DRAWN: BC	CHECKED: BC	JOB NO: 0260	THIS DESIGN	IN PART OR WHOLE IS SUBJECT TO COPYRIGHT © I NSPIRED BUILDING DESIGNS	A3		

Monday, 23 May 2022

page 7/13

			Laundr	y ventila	tion sy	stem	
ntrol		Each	laundry		Operat	ion con	trol
on/o	ff		al ventilation or no laundi		8		
n on/o	ff		al ventilation or no laundi		ti.		
ing					Na	tural lig	hting
throoms/ Each lets		ry All hal	llways	No.	of trooms r	Main kitch	
		yes	yes	s.:	5		no
1		67	et.				
	ienc	y meas	sures				
	CI	20	Clothes dryer	Indoo shelte clothe drying	ared 55	unsh cloth	oor or eltere

Monday, 23 May 2022

page 9/13

D	Elevation 3
	Lievation 5
N UPDATE)	2 X 7 4
N UPDATE)	5 ( X X ) 5
ED (SEWER PUMP)	afi ((X)) afi
ED (RFI)	Elevation 2
	Elevation 1

ii) Thermal Comfort	Show on DA plans	Show on CC/CDC plans & specs	Certifie
(a) The applicant must attach the certificate referred to under "Assessor details" on the front page of this BASIX certificate (the "Assessor Certificate") to the development application and construction certificate application for the proposed development (or the applicant is applying for a complying development certificate for the proposed development, to that application). The applica- must also attach the Assessor Certificate to the application for a final occupation certificate for the proposed development.			
(b) The Assessor Certificate must have been issued by an Accredited Assessor in accordance with the Thermal Comfort Protocol.	1		
(c) The details of the proposed development on the Assessor Certificate must be consistent with the details shown in this BASIX Certificate, including the details shown in the "Thermal Loads" table below.	e e		
(d) The applicant must show on the plans accompanying the development application for the proposed development, all matters which the Thermal Comfort Protocol requires to be shown on those plans. Those plans must bear a stamp of endorsement from the Accredited Assessor, to certify that this is the case.	~		
(e) The applicant must show on the plans accompanying the application for a construction certificate (or complying development certificate, if applicable), all thermal performance specifications set out in the Assessor Certificate, and all aspects of the propos development which were used to calculate those specifications.	ed	~	
(f) The applicant must construct the development in accordance with all thermal performance specifications set out in the Assessor Certificate, and in accordance with those aspects of the development application or application for a complying development certificate which were used to calculate those specifications.		~	
(g) Where there is an in-slab heating or cooling system, the applicant must:			
(aa) Install insulation with an R-value of not less than 1.0 around the vertical edges of the perimeter of the slab; or			
(bb) On a suspended floor, install insulation with an R-value of not less than 1.0 underneath the slab and around the vertical edges of the perimeter of the slab.	t is		
(h) The applicant must construct the floors and walls of the development in accordance with the specifications listed in the table below.	~	~	
(i) The applicant must show on the plans accompanying the development application for the proposed development, the locations of ceiling fans set out in the Assessor Certificate.	t 🖌		
(j) The applicant must show on the plans accompanying the application for a construction certificate (or complying development certificate, if applicable), the locations of ceiling fans set out in the Assessor Certificate.		V	

			Construction of floors and wa	alls	
Dwelling no.	Concrete slab on ground(m <sup>2</sup> )	Suspended floor with open subfloor (m <sup>2</sup> )	Suspended floor with endclosed subfloor (m <sup>2</sup> )	Suspended floor above garage (m <sup>x</sup> )	Primarily rammed earth or mudbrick walls
1	153	÷		*	No
All other dwellings	149	(#) <sup>1</sup>	#	32	No

				Therma	I loads		
	Dwelling no.	Area adjusted heating I	oad (in mJ/m²/yr)		Area adjusted cool	ling load (in mJ/m²/yr)	
	1	16.3	100 - 1971.		18.7		
	All other dwellings	12.7			27.1		].
					64		
BA	SIX Planning, Industry & Environmen	www.basix.nsw.gov.au	Version: 3.0 / DARWINIA_3_20_0	Certifica	ste No.: 1289269M	Monday, 23 May 2022	page 10/13

page 10/13 BASIX

Planning, Industry & Environment www.basix.nsw.gov.au Version: 3.0 / DARWINIA\_3\_20\_0

3. Commitments for common areas and central systems/facilities for the development (non-building specific)

### (b) Common areas and central systems/facilities

(i) Water	Show on DA plans	Show on CC/CDC plans & specs	Certifier check
(a) If, in carrying out the development, the applicant installs a showerhead, toilet, tap or clothes washer into a common area, then that item must meet the specifications listed for it in the table.	2	~	~
(b) The applicant must install (or ensure that the development is serviced by) the alternative water supply system(s) specified in the "Central systems" column of the table below. In each case, the system must be sized, be configured, and be connected, as specified in the table.	~	~	
(c) A swimming pool or spa listed in the table must not have a volume (in kLs) greater than that specified for the pool or spa in the table.	~	~	
(d) A pool or spa listed in the table must have a cover or shading if specified for the pool or spa in the table.		~	
(e) The applicant must install each fire sprinkler system listed in the table so that the system is configured as specified in the table.		~	
(f) The applicant must ensure that the central cooling system for a cooling tower is configured as specified in the table.	0	~	~

Common area	Showerheads rating	Toilets rating	Taps rating	<b>Clothes washer</b>	's rating	
All common areas	no common facility	no common facility	no common facility	no common laun	dry facility	
(ii) Energy				Show on DA plans	Show on CC/CDC plans & specs	Certifier check
			service a common area specified in the table n area, and must meet the efficiency measure		~	~
specified in	the table below, the lighting spe nt must also install a centralised	cified for that common area. This light	of artificial lighting" for each common area hting must meet the efficiency measure specifie fanagement System (BMS) for the common are		~	~
The applica where spec	med.					

Version: 3.0 / DARWINIA\_3\_20\_0

### Notes

2.	The applicant must identify each dwelling, building and common area listed in this certificate, on the plans acc specifications accompanying the application for a construction certificate / complying development certificate, reference as is given to that dwelling, building or common area in this certificate.
3.	This note applies if the proposed development involves the erection of a building for both residential and non- residential and non-residential purposes). Commitments in this certificate which are specified to apply to a "c the building or development to be used for residential purposes.
4.	If this certificate lists a central system as a commitment for a dwelling or building, and that system will also ser system need only be installed once (even if it is separately listed as a commitment for that other dwelling or b
5.	If a star or other rating is specified in a commitment, this is a minimum rating.
6.	All alternative water systems to be installed under these commitments (if any), must be installed in accordance NSW Health does not recommend that stormwater, recycled water or private dam water be used to irrigate en human consumption in areas with potable water supply.

~	-	14		+ +	11.00		140			10.00	20		-	-	1		1.								11
	de	avelop	men	it ap	plica	tion	1 is t	o be	lodge	d for	the p	prop	osed	dev	elop	me	nt).								
		eromen.	ien ie	5 100	21 TUER	5U V	wiur	-		e	104	one	n p	0110		unn	CTOBAS	se ne	ano	en o	n pie	a bie	3110-0	annon	

certificate / complying development certificate for the proposed development.

3. Commitments identified with a "v" in the "Certifier check" column must be certified by a certifying authority as having been fulfilled. (Note: a certifying authority must not issue an occupation certificate (either interim or final) for a building listed in this certificate, or for any part of such a building, unless it is satisfied that each of the commitments whose fulfilment it is required to monitor in relation to the building or part, has been fulfilled).

Planning, Industry & Environment www.basix.new.gov.au Version: 3.0 / DARWINIA\_3\_20\_0

USE FIGURED DIMENSIONS AT ALL TIMES. REFER ANY DISCREPENCIES TO INSPIRED BUILDING DESIGNS . FAILURE TO DO SO WILL

Planning, Industry & Environment www.basix.nsw.gov.au

VOID DESIGNERS RESPONSIBILITIES. ALL DIMENSIONS TO BE VERIFIED ON SITE PRIOR TO CONSTRUCTION. ALL WORK TO COM	IPLY
WITH LOCAL AUTHORITY REGULATIONS AND BCA. ANY 3D PERSPECTIVES ARE FOR ILLUSTRATION PURPOSES ONLY.	

BASIX

REAL PROPERTY DESCRIPTION		PROJECT ADDRESS:		CLIENT:			PROJECT:	PROJECT:			A 17/02/22 PRELIMINA		
							NEW RESIDE				B 09/03/22 CONTRACT		
PLAN NUMBER: DP1273771		LOT 6 #12 KANOOK		J WAGEE .	+ W KELLY							T PLANS (SITEPLAN UPDATE)	
			BUILDER:								T PLANS (SITEPLAN UPDATE)		
LOCAL AUTH: TWEED SHIRE		BOGANGAR NSW	BOILDER.			STAGED PLAN:					T PLANS RE-ISSUED (SEWER PUMP)		
LOCAL AUTH. TWEED STIILE		DUGANGAN NOW				CONTRACT	CONTRACT			E 26/04/23 CONTRACT	T PLANS RE-ISSUED (RFI)		
							eenninen						
AREA: 1008 m2		DWG NO: 904 SCALE:	DATE: 26/04/2023	DRAWN:	CHECKED: BC	JOB NO: 0260	THIS DESIGN IN PART OR WHOLE IS SUB.	N PART OR WHOLE IS SUBJECT TO COPYRIGHT © I NSPIRED BUILDING DESIGNS					
		904	ВС		0200				F				

Monday, 23 May 2022

page 12/13

BASIX

Certificate No.: 1289269M

Certificate No.: 1289269M

Monday, 23 May 2022

page 11/13

ccompanying any development application, and on the plans and te, for the proposed development, using the same identifying letter or.

n-residential purposes (or the change of use of a building for both "common area" of a building or the development, apply only to that part of

ervice any other dwelling or building within the development, then that r building).

ce with the requirements of all applicable regulatory authorities. NOTE: edible plants which are consumed raw, or that rainwater be used for

anying the development application for the proposed development (if a

2. Commitments identified with a """ in the "Show on CC/CDC plans and specs" column must be shown in the plans and specifications accompanying the application for a construction.

Certificate No.: 1289269M

Monday, 23 May 2022

page 13/13

